OSSM, Orchard Hills, NSW 2748

Landscape Documentation for Development Application



IMAGE TAKEN FROM NEARMAP 2024

PLANTING SCHEDULE

Code	Botanical Name	Common Name	Mature Height	Spacing	Install Size	Shale Plain Woodlands	Native	Qty*
Trees								
CUP ANA	Cupaniopsis anacardioides	Tuckeroo	8m	As Shown	25L		✓	3
EUC MOL	Eucalyptus moluccana	Grey Box	25m	As Shown	75L	✓	✓	2
MEL STY	Melaleuca stypheliodes	Prickly-leaved Paperbark	10m	As Shown	75L		✓	2
WAT FLO	Waterhousia floribunda 'DOW20' Sweeper	Weeping Lilly Pilly	10m	As Shown	25L		✓	5
Shrubs								
ACM smi	Acmena smithii 'DOW30'	Sublime	1.5m**	1000mm Ctrs	200mm		✓	54
LEP for	Leptospermum 'Foreshore'	Tea Tree	0.5m	500mm Ctrs	200mm		✓	153
LIS str	Lissanthe strigosa	Peach Heath	1m	As Shown	200mm	✓	✓	49
WES blu	Westringia hybrid 'WESO3'	Blue Gem Westringia	1m	As Shown	200mm		✓	27
Accent Sh	rubs							
DOR exc	Doryanthes excelsa	Gymea Lily	2-4m	As Shown	200mm		✓	17
Grasses &	Groundcovers							
ASP con	Asperula conferta	Common Woodruff	0.3m	3/m2	140mm	✓	✓	65
ANI bus	Anigozanthos 'Bush Diamond'	White Kangroo Paw	0.5m	4/m2	140mm		✓	131
DIA bre	Dianella caerulea 'Breeze'	Blue Native Flax	0.7m	5/m2	Tubestock		✓	513
DIA lon	Dianella longifolia	Smooth Native Flax	1m	4/m2	Tubestock	✓	✓	87
DIC rep	Dichondra repens	Kidney Weed	0.15m	3/m2	140mm	✓	✓	210
LOM con	Lomandra confertifolia 'LM700'	Pacific Sky Mat Rush	0.75m	5/m2	Tubestock		✓	470
LOM mul	Lomandra multiflora	Many Flower Mat Rush	0.85m	4/m2	Tubestock	✓	✓	87
LOM nya	Lomandra longifolia 'Nyalla'	Spiny Head Mat Rush	0.8m	5/m2	Tubestock		✓	942
LOM tan	Lomandra longifolia 'LM300'	Lomandra Tanika	0.5m	5/m2	Tubestock		✓	464
PRA pur	Pratia purpurascens	White Root	0.3m	3/m2	140mm	✓	✓	168
SCA aem	Scaevola aemula 'Fairy White'	White Fan Flower	0.3m	3/m2 OR 2/Lm	140mm		✓	107
WES low	Westringia fruticosa 'WESO6'	Low Horizon Westringia	0.3m	3/m2 OR 2/Lm	140mm		✓	54
				T	otal Plant Numbers			3610

^{*} To be finalised during CC/Tender

Drawing Title:

Landscape Cover SheetDWG No:





Client:



SITE PLAN

Scale: Date: Job Number: NTS 04.02.25 240612 Project: OSSM Orchard Hills, N

Job Number: North: Revision FOR DEVELOPMENT APPLICATION 240612 Rev Date Description Drawn Checked A 10.07.24 DRAFT FOR REVIEW PT BG B 24.07.24 FOR DA PT/SK BG C 31.01.25 FOR DA PT/SK BG D 04.02.25 FOR DA PT BG

Drawing Register

Dwg No.	Drawing Name
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_DA-00	Landscape	Cover Sheet
_DA-01	Landscape	Master Plan
_DA-02	Landscape	Section AA


LDA-03 Typical Landscape Frontage Section
LDA-04 Specification, Details & Planting Schedule

Appendix

11178_DA280 OSSM Irrigation - Indicative Irrigation Plan (Plan By Nettleton Tribe)



^{**} Plants to be trimmed to heights indicated

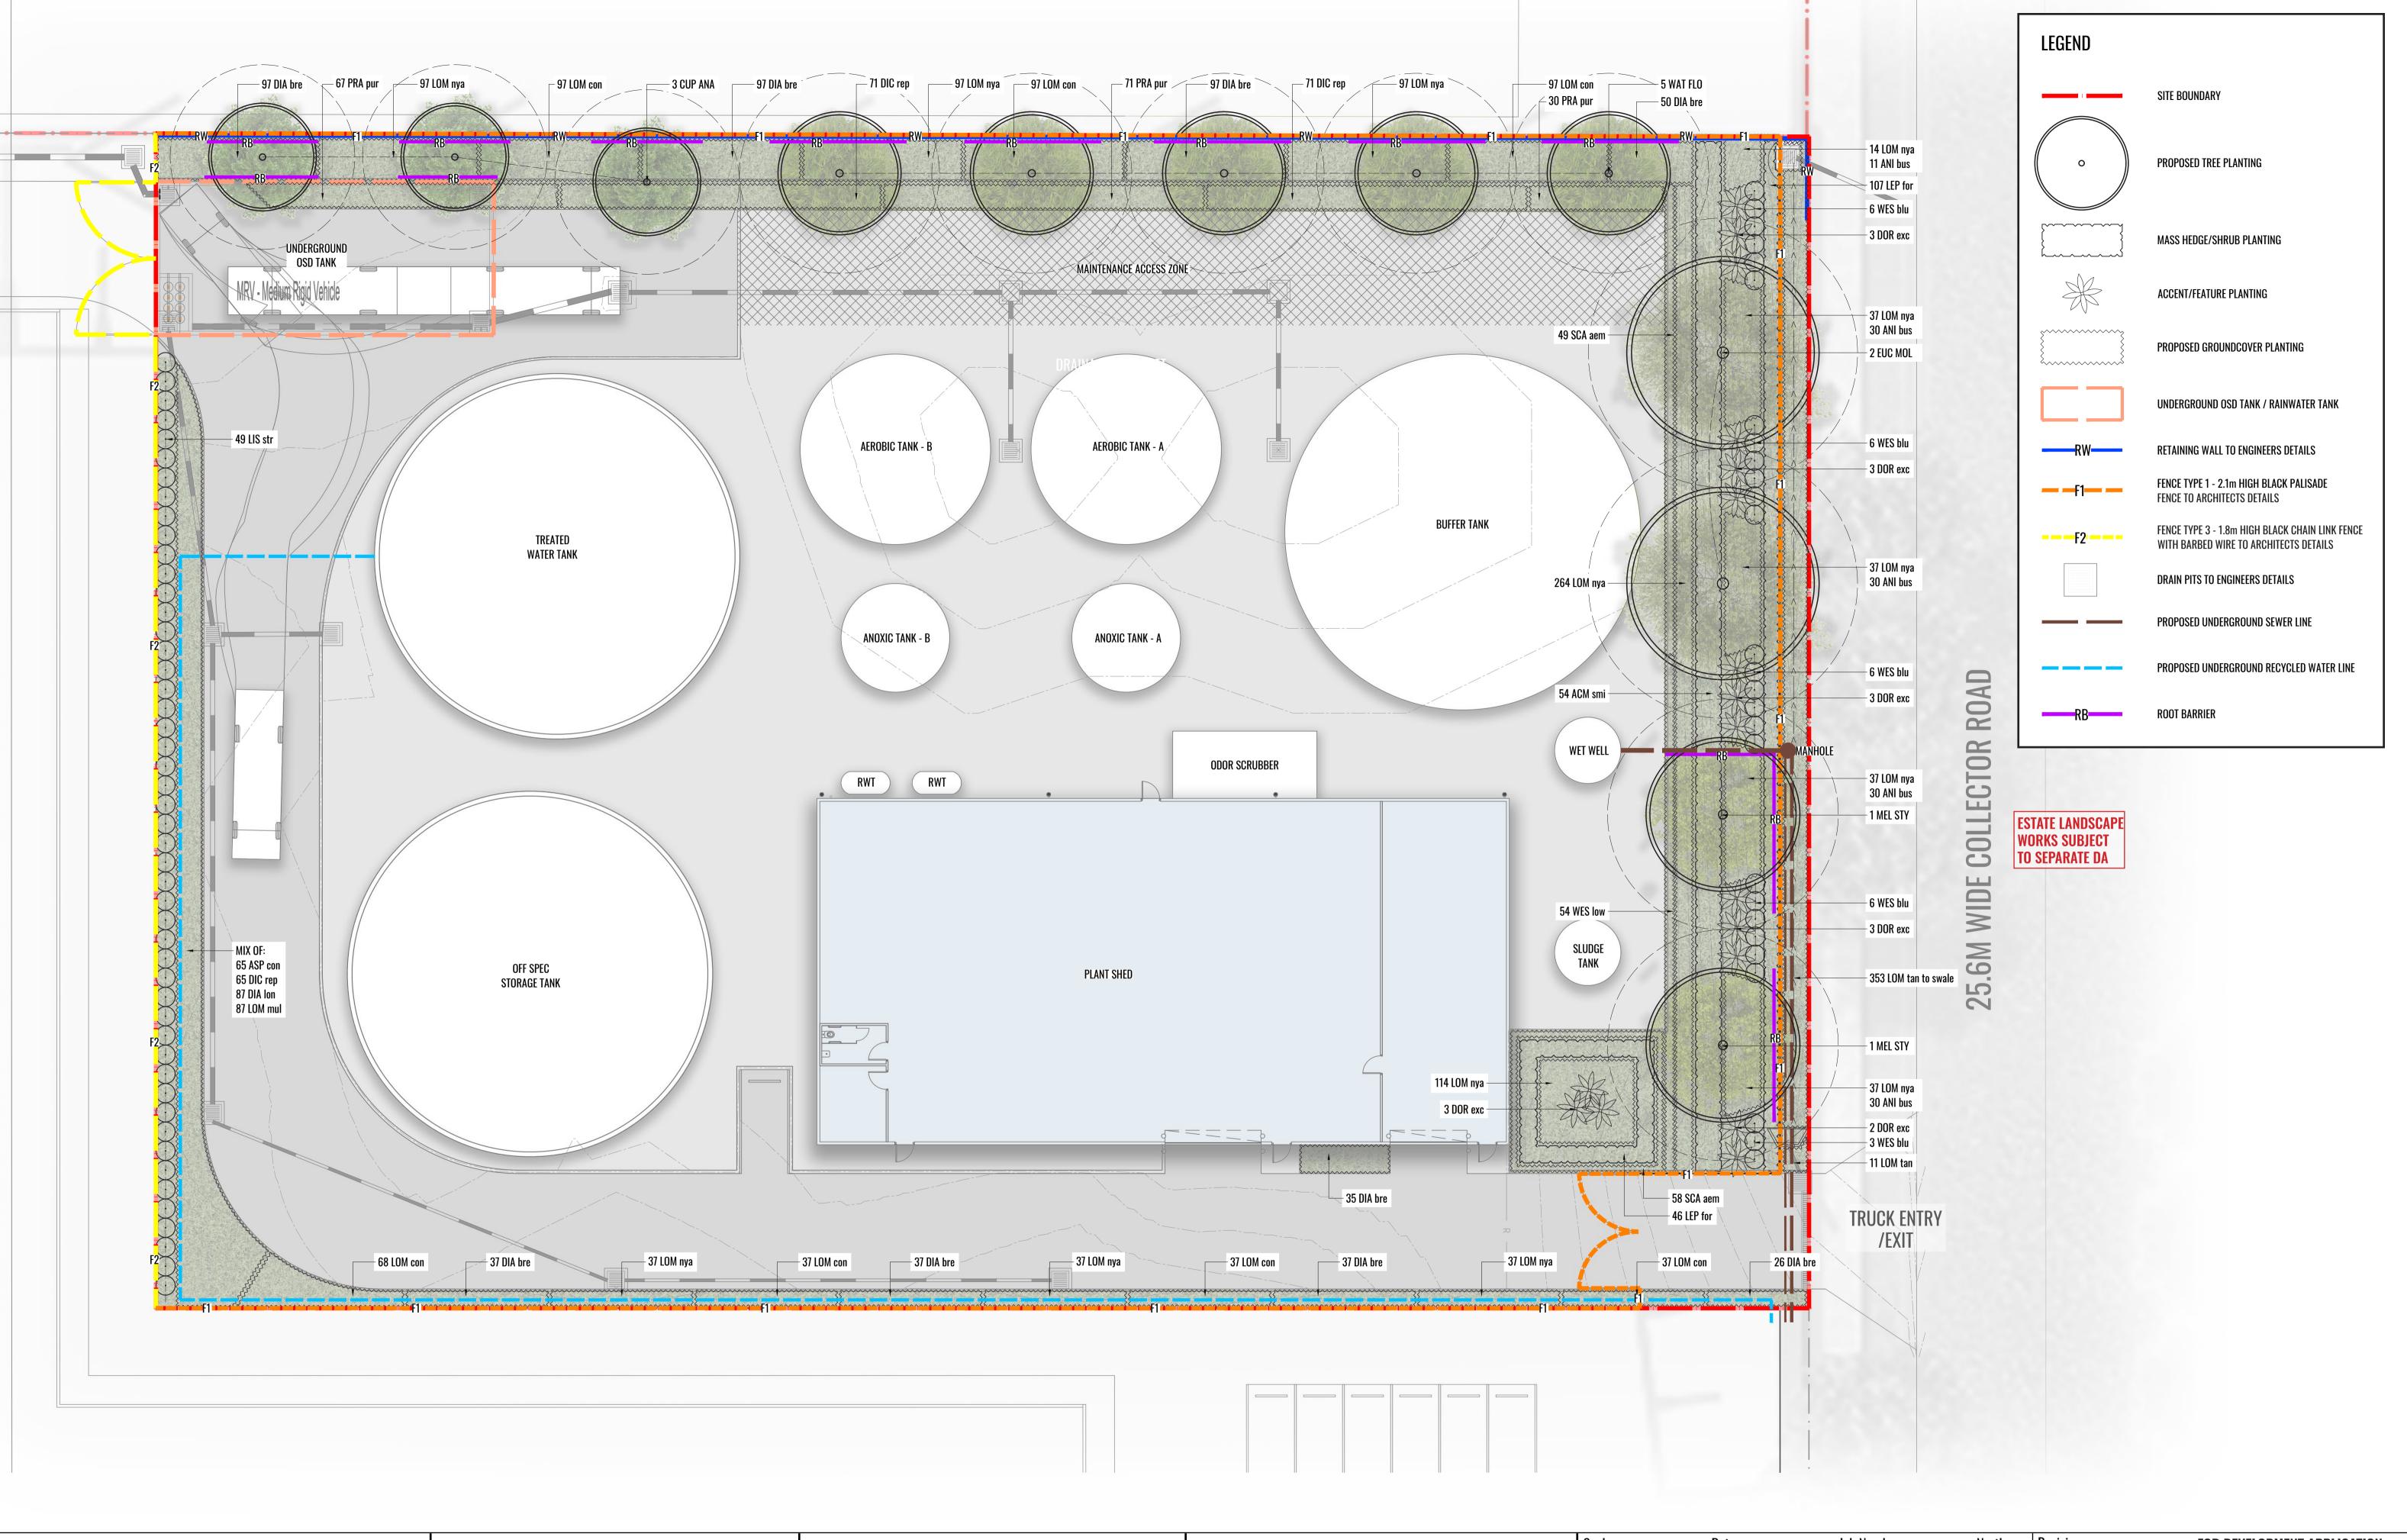

Drawing Title:

Landscape Master PlanDWG No:

.DA-01

Suite 303, 8 Help Street, Chatswood NSW 2067 Ph. (02) 9411 1485 www.geoscapes.com.au ABN 84 620 205 781 ACN 620 205 781







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1:500@ A1	04.00.05	0.40010		Re
1:1000@ A3	04.02.25	240612		A
D : 1		OCCM		В
Project:		OSSM		C
		Orchard Hi	ills, NSW 2748	D

: Revision			FOR DEVELOPM	ENT APF	PLICATION
)	Rev	Date	Description	Drawn	Checked
	A	10.07.24	DRAFT FOR REVIEW	PT	BG
	В	24.07.24	FOR DA	PT	BG
	C	31.01.25	FOR DA	PT/SK	BG
748	D	04.02.25	FOR DA	PT	BG



SECTION AA

SCALE 1:20



KEY PLAN



Drawing Title:

DWG No:

Landscape Section AA










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ъ	DOCA B	24.07.24	FOR DA	PT	BG			
Project:		OSSM		C	31.01.25	FOR DA	PT/SK	BG
		Orchard Hi	ills, NSW 2748	D	04.02.25	FOR DA	PT	BG

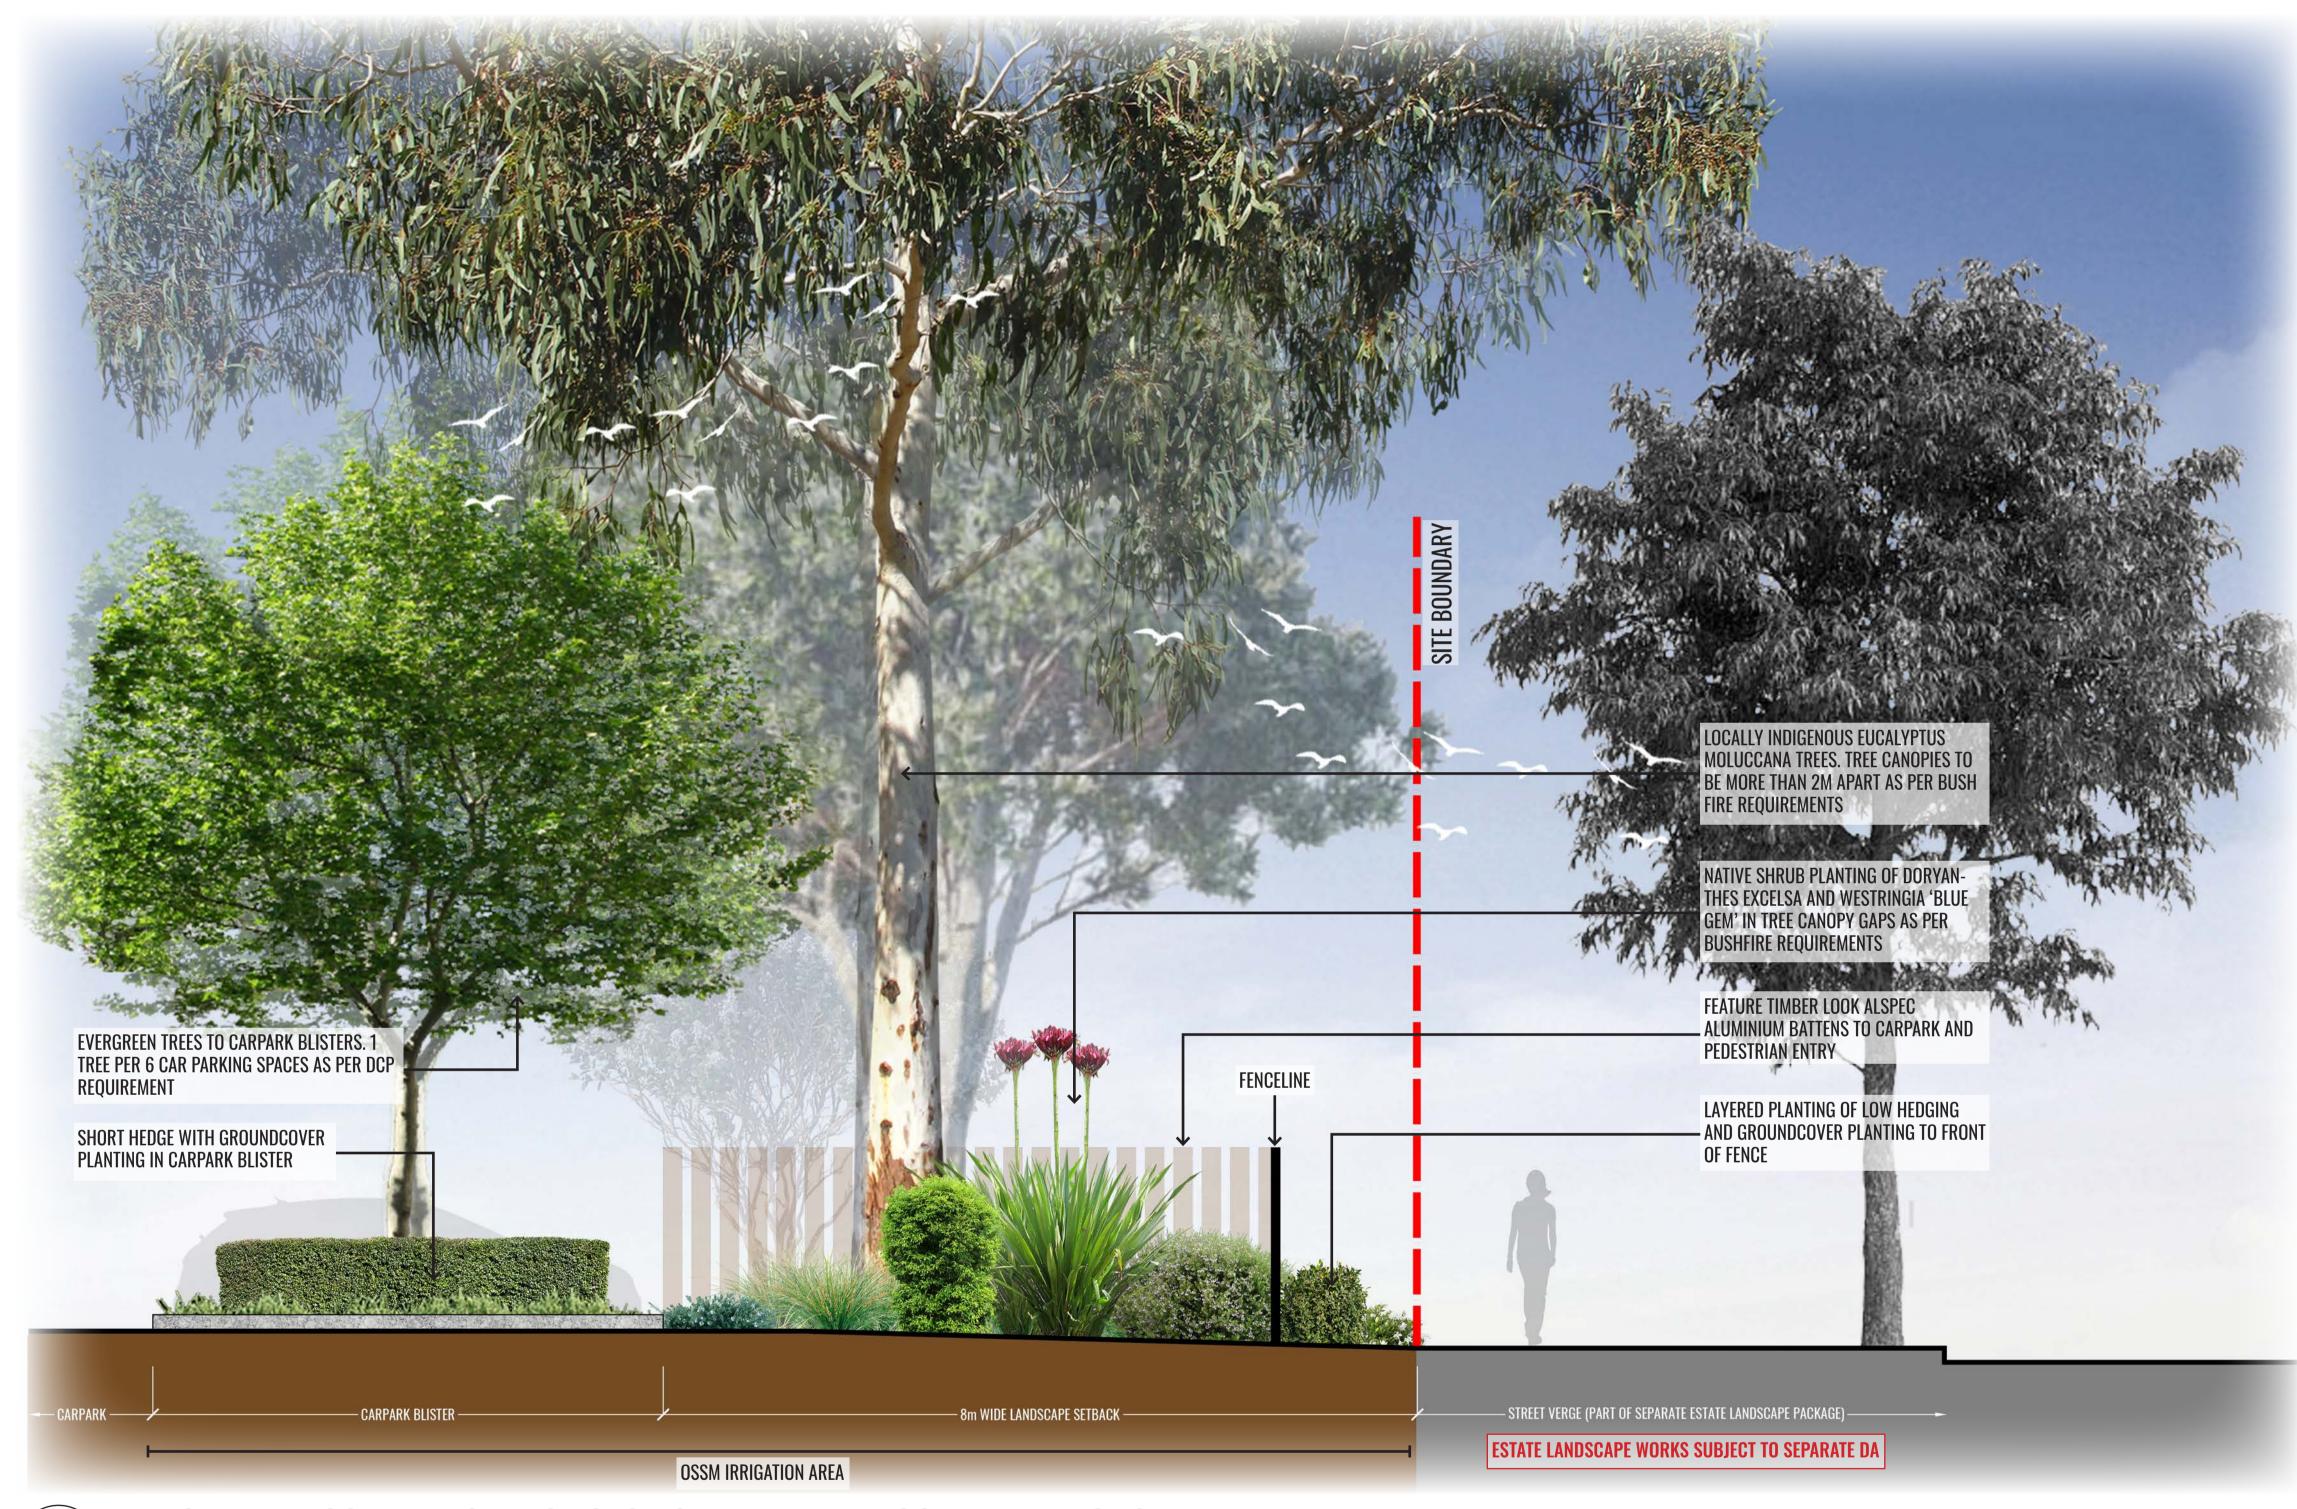

TYPICAL LANDSCAPE FRONTAGE SECTION - EXAMPLE: COPE WAREHOUSE SCALE 1:20

Drawing Title:

Typical Landscape Frontage Section

DWG No: LDA-

Section
LDA-03







Scale:	Date:	Job Number:	North:	Revision FOR DEV		FOR DEVELO	PMENT API	PLICATION
	04.00.05	0.40010		Rev	Date	Description	Drawn	Checked
AS SHOWN @ A1	04.02.25	240612		A	10.07.24	DRAFT FOR REVIEW	PT	BG
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Project:		OSSM		C	31.01.25	FOR DA	PT/SK	BG
		Orchard H	ills, NSW 2748	D	04.02.25	FOR DA	PT	BG

MAINTENANCE PLAN

Maintenance shall mean the care and maintenance of the landscape works by accepted horticultural practice as rectifying any defects that become apparent in the landscape works under normal use. The landscape contractor shall attend the site on a weekly basis to maintain the landscape works commencing from practical completion.

Rubbish Removal

The Landscape Contractor shall undertake rubbish removal from the site on a weekly basis to ensure the site remains in tidy condition.

Weed Eradication

Weed growth that may occur in grassed, planted or mulched areas is to be removed using environmentally acceptable methods i.e. non-residual glyphosate herbicide (e.g. 'Roundup', applied in accordance with the manufacturer's direction.

Tree Replacement

Trees shall show signs of healthy vigorous growth and be free from disease and not exhibit signs of stress prior to handover to the client. Any trees or plant that die or fail to thrive, or are damaged or stolen will be replaced. Replacement material shall have the initial maintenance period extended in accordance with the landscape contract conditions. Trees and plant materials shall be equal to the minimum requirements of species specified and approved material delivered to site. Should the condition decline from the approved sample the Superintendent reserves the right to reject the tree / plants. Frequency: as required.

Stakes

Pruning

Adjust and/or replace stakes and ties where required. Remove staking and guying when instructed by the Superintendent

Selective pruning may be required during the establishment period to promote a balanced canopy structure. These activities shall be carried out to the best horticultural and industry practice. All pruned material is to be removed from site.

Mulched Surfaces

All planter beds and garden areas shall have a minimum depth of 75mm organic mulch. All mulch is to be free of deleterious matter such as soil, weeds, sticks and should conform to AS 4454.

Mulched surfaces are to be kept clean and tidy and free of any deleterious material and foreign matter. Reinstate depths to a uniform level of 75mm with mulch as specified, mulch to be free of any wood material impregnated with CCA or similar toxic treatment. Top up mulch levels prior to handover to client & estate management

Soil In Natural Ground

All soils to conform to the landscape typical details shown in GEOSCAPES drawings. For soils in locations where Recycled Water is used for irrigation, refer to soil specs from Whitehead & Associates Environmental Consultants documentation and project specific advice from SESL documentation.

Pest and Disease Control

The Landscape Contractor shall spray for pests and disease infestations when the pest and fungal attack has been positively identified and when their populations have increased to a point that will become detrimental to plant growth. Apply all pesticides to manufacturer's directions. Frequency: weekly inspection

Fertilising

Generally, check for signs of nutrient deficiencies (yellowing of leaves, failure to thrive), and adapt fertiliser regime to suit. Fertiliser should be applied at the beginning and the end of the (summer) growing season.

Irrigation


Irrigation will be provided through two systems. The first will be delivered through water treated at the OSSM, the second will be delivered through harvested rainwater. The Recycled Water and harvested rainwater are used in specific landscape areas as shown in the Appendix on NettletonTribe Plan 11178_ DA280. The fully automatic irrigation system has been designed by Total Irrigation Design and these drawings and specifications should be used for design and installation.

Standards

All grown or purchased plant stock must conform to all the conditions and requirements given in NATSPEC Guide: Specifying Trees. Soils to be in accordance with AS4419, mulching composts and conditioners to be in accordance with AS4454. Soils should conform to best practice specifications as listed in the Landscape Soils Handbook (Simon Leake & Elke Haege 2017).

TYPICAL LANDSCAPE DETAILS


TAKE CARE TO ENSURE FOLIAGE, BRANCHES, TRUNKS AND ROOT CROWNS ARE NOT DAMAGED BEFORE, DURING AND AFTER PLANTING. ENSURE OPTIMUM MAINTENANCE AND ESTABLISHMENT OF TREES/SHRUBS OCCURS AS SOON AS THEY ARE AT SITE

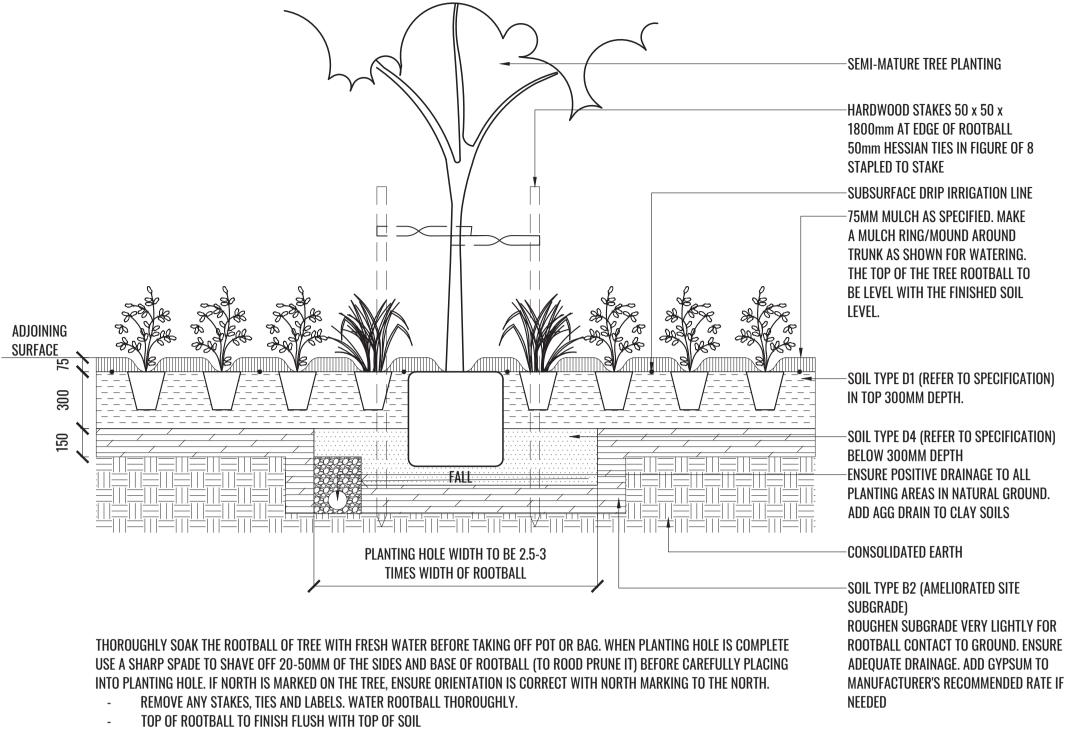

MASS PLANTING AND TREE DETAIL FOR AREAS IRRIGATED BY RAINWATER

SCALE 1:20

TAKE CARE TO ENSURE FOLIAGE, BRANCHES, TRUNKS AND ROOT CROWNS ARE NOT DAMAGED BEFORE, DURING AND AFTER PLANTING. ENSURE OPTIMUM MAINTENANCE AND ESTABLISHMENT OF TREES/SHRUBS OCCURS AS SOON AS THEY ARE AT SIT

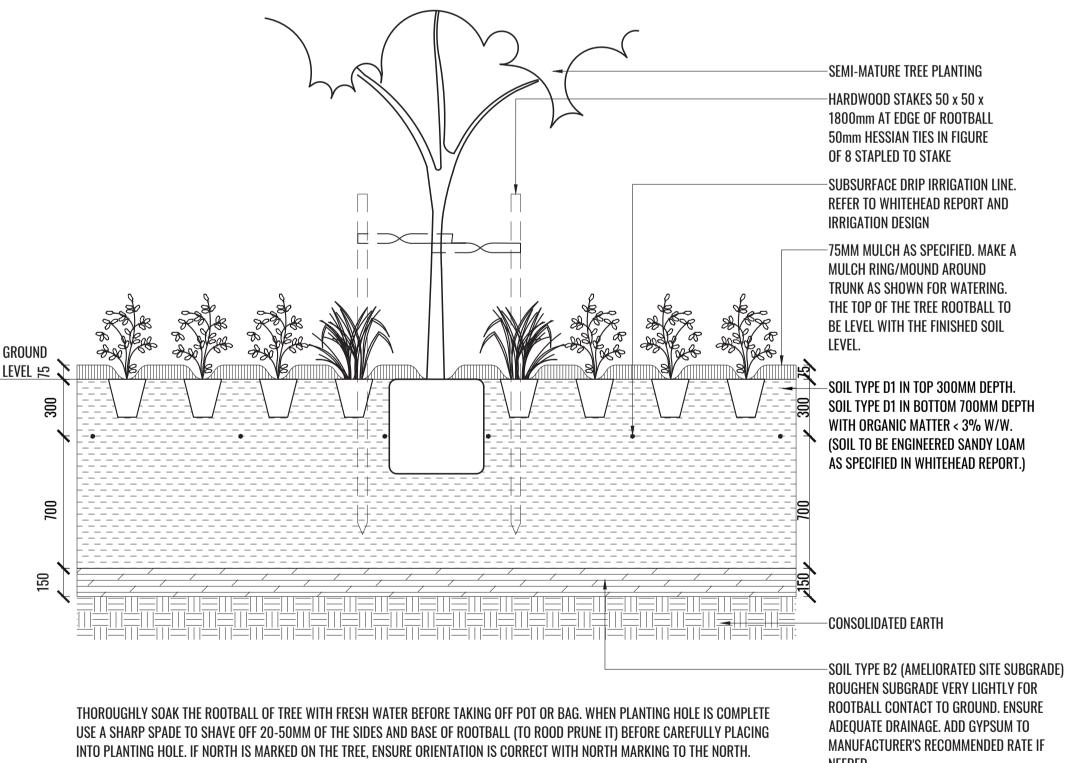


REMOVE ANY STAKES, TIES AND LABELS. WATER ROOTBALL THOROUGHLY. TOP OF ROOTBALL TO FINISH FLUSH WITH TOP OF SOIL

ALL DRAWINGS AND SPECIFICATIONS ON LANDSCAPE DRAWINGS AND DETAILS THAT RELATE TO AREAS RECEIVING RECYCLED WATER IRRIGATION SHOULD BE READ IN CONJUNCTION WITH SESL REPORTS AND WHITEHEAD & ASSOCIATES **ENVIRONMENTAL CONSULTANTS DOCUMENTATION**

REFER TO APPENDIX (NETTLETON TRIBE DRAWING 11178 DA280) FOR AREAS TO BE IRRIGATED WITH RECYCLED WATER OR RAINWATER

PRECAST SLEEPER RETAINING **WALL DETAIL**

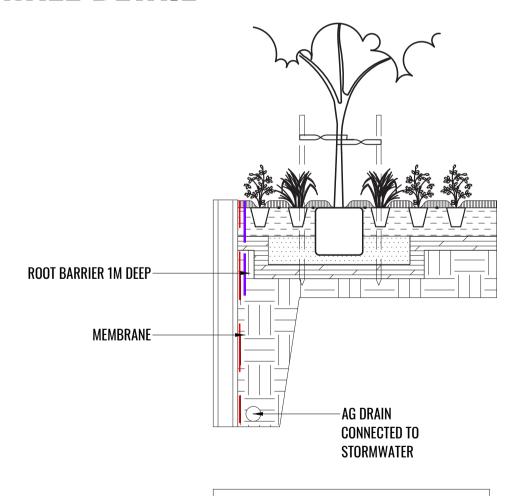

ALL SLEEPER WALL DETAILS AND HEIGHT TO FOLLOW STRUCTURAL ENGINEERS DETAILS

YPICAL PLANTING DETAIL TO PRECAST SLEEPER RETAINING WALL SCALE 1:40

Drawing Title:

Specification, Details & Planting Schedule DWG No:

Suite 303, 8 Help Street, Chatswood NSW 2067 Ph. (02) 9411 1485 www.geoscapes.com.au ABN 84 620 205 781 ACN 620 205 781

Architect: nettletontribe architecture

TYPICAL SECTION



MASS PLANTING AND TREE DETAIL FOR AREAS IRRIGATED BY RECYCLED WATER



SCALE 1:20


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	04.00.05	0.40010		Rev	Date	Description	Drawn	Checked
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roject:				C	31.01.25	FOR DA	PT/SK	BG
		Orchard H	ills, NSW 2748	D	04.02.25	FOR DA	PT	BG

APPENDIX

13-Aug-24	DA280
TOTAL LANDTAKE (m²)	1,253,773
TOTAL IRRIGATION AREA ACHIEVED (ha)	21.50
Other Site Stormwater Catchments Via Bioretention And Storage Ponds (ha)	13.80
Collector Road and Patons Lane landscape strips (ha)	0.78
OSSM Treated Water Irrigation Area (ha)	3.65
Harvested Rainwater and Stormwater Irrigation Area (ha)	3.27
TOTAL IRRIGATION AREA REQUIRED (ha)	18.44
NW and SE catchments (ha)	11.44
NE catchment on Lot 1 (ha)	0.47
Rainwater tanks on lots (ha)	2.88
Treated water from OSSM Facility (ha)	3.65
IRRIGATION AREA SURPLUS (ha)	3.06






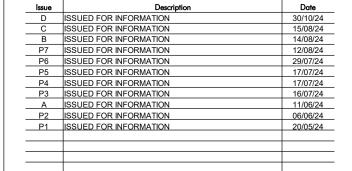

Builder and/or subcontractors shall verify all project dimensions before commencing on-site work or off-site fabrication. Figured dimensions shall take precedence over scaled dimensions. This drawing is copyright and cannot be reproduced in whole or in part or by any medium without the written permission of Nettleton Tribe Partnership Pty Ltd.

Project Name
Alspec Industrial Business Park
Project Address
Luddenham Road, Orchard Hills NSW

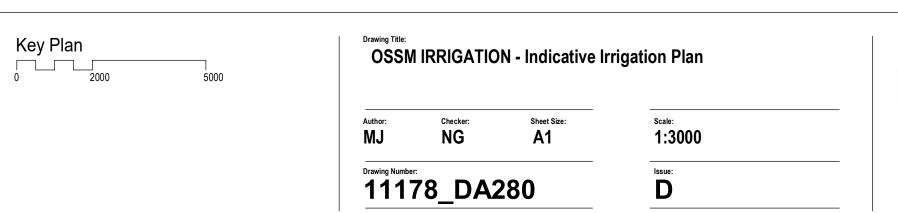

nettletontribe

nettleton tribe partnership pty ltd ABN 58 161 683 122
117 Willoughby Road, Crows Nest, NSW 2065
t +61 2 9431 6431
e: sydney@nettletontribe.com.au w: nettletontribe.com.au